

## GENERAL NOTES

\*\*\* ALL NOTES HOLD TRUE THRUOUT HOUSE UNLESS OTHERWISE NOTED \*\*

1, ALL EXTERIOR WALLS TO BE 2X6 STUD WALLS @ 16" O.C. UNLESS NOTED OTHERWISE ON PLAN

3. ALL EXTERIOR DOOR AND WINDOW HEADERS TO BE (2) 2x12's, w/ 2 JACK STUDS TO SUPPORT HEADER.

4. (9) = 110V. INTER-CONNECTED SMOKE DETECTOR W. BATTERY BACK-UP.

5. (a) = SOLED BLOCKING TO T/FDN OR T/BEAM BELOW (3 JACK STUD MIN.)

6. 1 3/4" WOOD OR STEEL INSULATED EXTERIOR DOORS.

7, 1 3/4" WOOD 6-PANEL INTERIOR DOORS.

8. ALL STAIR RAILINGS TO BE NO LESS THAN 35" ABV. NOSING AND BALUSTERS SPACED LESS THAN 4" CLEAR.

9. THE ENDS OF ALL 1/2 WALLS NOT VERTICALLY SUPPORTED SHALL PENETRATE SUBFLOOR W/ (2) 2X4'S AND THE SECURELY INTO THE FLOOR JOISTS BELOW W/ SOLID BLOCKING ON ALL 4 SIDES.

10. WINDOW HEADERS TO BE AT 9'- 9 3/8" ABOVE EACH FLOOR UNLESS OTHERWISE NOTED.

FIRST FLOOR TRUSS AND SUBFLOOR MUST BE INSTALLED AND SECURELY FASTENED TO FOUNDATION ANCHORAGE BEFORE BACKFILLING.

### STAIR NOTE

GUARDRAIL SHALL BE DESIGNED TO SUPPORT 200bs CONCENTRATED LOAD APPLIED IN ANY DIRECTION AT ANY POINT ALONG THE TOP GUARD, AND 50ps/AT THE INFILL COMPONENTS OF THE GUARD

INDIVIDUAL STAIR TREADS SHALL BE DESIGNED FOR THE UNIFORMLY DISTRIBUTEDV LIVE LOAD OF 40pef OR A 300the CONCENTRATED LOAD ACTING OVER AN AREA OF 4 SQUARE INCHES, WHICHEVER PRODUCES THE GREATER STRESSES.

## TRUSS NOTES

TRUSS COMPANY SHOULD CHECK FLOOR PLANS AND BUILDING SECTIONS. IF DISCREPANCIES FOUND, CALL ARCHITECT IMMEDIATELY.

IF TRUSS DESIGN, INCLUDING POINT LOADS, UNIFORM TRUSS LOADS, ETC. VARIES FROM WHAT IS SHOWN ON THE PLANS, CALL ARCHITECT IMMEDIATELY.

IF HEEL CUTS NEED TO BE ADJUSTED BY TRUSS MANUFACTURER FROM WHAT SHOWN ON ELEVATIONS CALL ARCHITECT IMMEDIATELY.

PROVIDE CONTINUOUS BEARING TO FOUNDATION BELOW ALL MULTI- PLY TRUSSES.

TRAY AND COFFERED CLINGS ARE CONSTRUCTED WITHIN THE TRUSS CONFIGURATION UNLESS NOTED OTHERWISE

TRAY AND COFFERED CLINGS SHOULD CONSTRUCTED TO MAXIMUM INTERIOR HEIGHT THAT IS POSSIBLE. (COORDINATE W/ ARCHITECT)

ENGINEERED ROOF TRUSS DRAWINGS WITH A LAYOUT SHEET SHALL BE FURNISHED TO THE BUILDING INSPECTION FOR THE FRAMING INSPECTION


## HVAC / FLOOR SYSTEM ENGINEER NOTE:

GENERAL CONTRACTOR TO COORDINATE WITH HVAC CONTRACTOR, SYNTHESIS & OWNER ON HVAC CEILING DROPS & OR SHAFTS NEEDED, PRIOR TO ORDERING TRUSS PACKAGE

## SMOKE DETECTOR NOTE

SMOKE ALARMS SHALL BE INSTALLED ON EACH LEVEL OF THE HOUSE, AND SHALL UTLIZE PHOTOELECTRIC AND IONIZATION TECHNOLOGIES. SMOKE ALARMS IN THE VICINITY OF BEDROOMS SHALL UTRIZE PHOTOELECTRIC TECHNOLOGY. SMOKE ALARMS IN BEDROOMS SHALL BE DUAL-SENSING OR UTRIZE IONIZATION TECHNOLOGY.

PER RCO 310.2 - NET CLEAR OPENINGS SHALL BE NO LESS THAN 5.7 S.F.

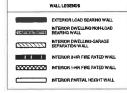

TOWNHOME

DRAKEWOOD

TYLER INVESTMENT PROPERTIES

INTERSECTION OF WASSON RD. OAKLEY, CINCINNATI, OH

223.5023 | studio@synthesisarchitecture.com synthesisarchitecture.com


Rev. No.	Description	Date

# **BUILDING MAIN &** SECOND LEVEL **PLANS**

Project Number	202110
Date	07.22.2022
Drawn By	MS
Checked By	NP

Scale

As indicated

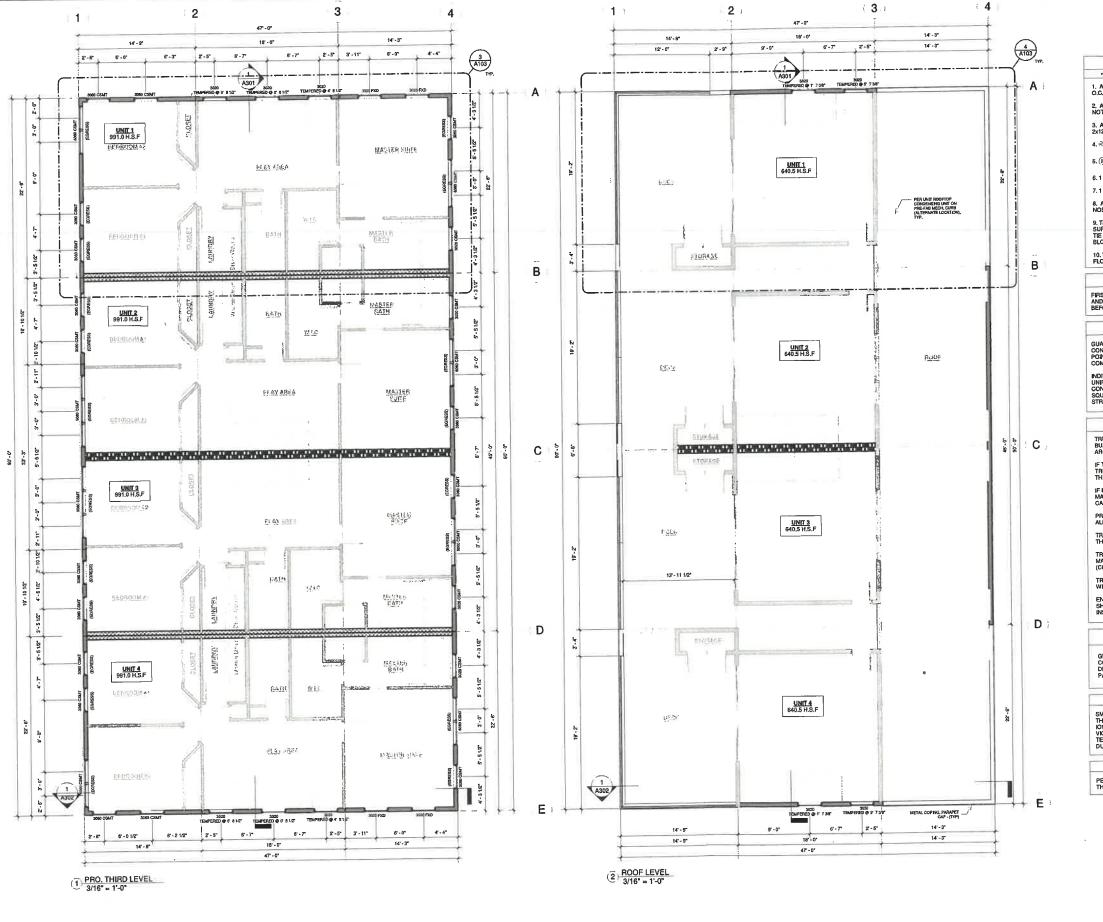

GENERAL NOTES

- \*\*\* ALL NOTES HOLD TRUE THRUOUT HOME UNLESS OTHERWISE NOTED \*\*\*

  ALL CYTERIOR WALLS TO BE 2YE STUD WALLS @ 15
- 1. ALL EXTERIOR WALLS TO BE 2X6 STUD WALLS @ 15° O.C. UNLESS NOTED OTHERWISE ON PLAN
- 2, ALL INTERIOR PARTITIONS TO BE 2x4 @ 16° O.C. UNLESS NOTED OTHERWISE ON PLAN
- 3. ALL EXTERIOR DOOR AND WINDOW HEADERS TO BE (2) 2x12's, w/2 JACK STUDS TO SUPPORT HEADER.
- 4. 0)<sub>SO</sub> = 110V. INTER-CONNECTED SMOKE DETECTOR W/
  BATTERY BACK-UP.
- 5. (8) = SOLID BLOCKING TO T/FDN OR T/BEAM BELOW (3 JACK STUD MIN.) 6. 1 3/4" WOOD OR STEEL INSULATED EXTERIOR DOORS.
- 7. 1 3/4" WOOD 6-PANEL INTERIOR DOORS.
- 8. ALL STAIR RAILINGS TO BE NO LESS THAN 96° ABV. NOSING AND BALUSTERS SPACED LESS THAN 4° CLEAR.
- 9. THE ENDS OF ALL 1/2 WALLS NOT VERTICALLY SUPPORTED SHALL PENETRATE SUBFLOOR W/ (2) 2X4'S AND TIE SECURELY INTO THE FLOOR JOISTS BELOW W/ SOLID BLOCKING ON ALL 4 SIDES.
- 10. WINDOW HEADERS TO BE AT 9'- 9 3/8" ABOVE EACH FLOOR UNLESS OTHERWISE NOTED.

FRAMING N

FIRST FLOOR TRUSS AND SUBFLOOR MUST BE INSTALLED AND SECURELY FASTENED TO FOUNDATION ANCHORAGE BEFORE BACKFILLING.

STAIR NOTE

GUARDRAIL, SHALL BE DESIGNED TO SUPPORT 2000s
CONCENTRATED LOAD APPLIED IN ANY DIRECTION AT ANY
POINT ALONG THE TOP GUARD, AND 50psf AT THE INFILL
COMPONENTS OF THE GUARD

INDIVIDUAL STAIR TREADS SHALL BE DESIGNED FOR THE UNIFORMLY DISTRIBUTEDV LIVE LOAD OF 40pd OR A 300bs CONCENTRATED LOAD ACTING OVER AN AREA OF 4 SQUARE NOHES, WHICHEVER PRODUCES THE GREATER STRESSES.

TRUSS NOTES

TRUSS COMPANY SHOULD CHECK FLOOR PLANS AND BUILDING SECTIONS. IF DISCREPANCIES FOUND, CALL ARCHITECT IMMEDIATELY.

IF TRUSS DESIGN, INCLUDING POINT LOADS, UNIFORM TRUSS LOADS, ETC. VARIES FROM WHAT IS SHOWN ON THE PLANS, CALL ARCHITECT IMMEDIATELY.

IF HEEL CUTS NEED TO BE ADJUSTED BY TRUSS MANUFACTURER FROM WHAT SHOWN ON ELEVATIONS CALL ARCHITECT IMMEDIATELY.

PROVIDE CONTINUOUS BEARING TO FOUNDATION BELOW ALL MULTI- PLY TRUSSES.

TRAY AND COFFERED CLNGS ARE CONSTRUCTED WITHIN THE TRUSS CONFIGURATION UNLESS NOTED OTHERWISE

TRAY AND COFFERED CLINGS SHOULD CONSTRUCTED TO MAXIMUM INTERIOR HEIGHT THAT IS POSSIBLE. ICOORDINATE W/ ARCHITECT)

TRUSSES TO BE CONFIGURED TO MAINTAIN OVERHANG WIDTH THE SAME FOR BRICK AND STONE VENEER AREAS.

ENGINEERED ROOF TRUSS DRAWINGS WITH A LAYOUT SHEET SHALL BE FURNISHED TO THE BUILDING INSPECTION

HVAC / FLOOR SYSTEM ENGINEER NOTE:

GENERAL CONTRACTOR TO COORDINATE WITH HVAC CONTRACTOR, SYNTHESIS & OWNER ON HVAC CELING DROPS & OR SHAFTS NEEDED, PRIOR TO ORDERNG TRUSS PACKAGE

SMOKE DETECTOR NOTE

SMOKE ALARMS SHALL BE NSTALLED ON EACH LEVEL OF THE MOUSE, AND SHALL UTILIZE PHOTOELECTRIC AND INDICATION TECHNOLOGIES, SMOKE ALARMS IN THE VICINITY OF BEDROOMS SHALL UTILIZE PHOTOELECTRIC TECHNOLOGY, SMOKE ALARMS IN BEDROOMS SHALL BE DUAL-SENSING OR UTILIZE IONIZATION TECHNOLOGY.

EMERGENCY ESCAPE & RESCUE OPENING

PER RCO 310.2 - NET CLEAR OPENINGS SHALL BE NO LESS THAN 5.7 S.F.



DRAKEWOOD TOWNHOME

**PROPERTIES** 

TYLER INVESTMENT

6.com INTERSECTION OF WASSON RD AND DRAKE

RCHITECTURE + PLANNING + INTERIORS

1077 CELESTIAL ST. SUITE 205, CINCINNATI, OH 45202

0.513.223.5023 | studio@synthesisarchitecture.com
synthesisarchitecture.com

Rev. No.	Description	Date
-		

# BUILDING THIRD LEVEL AND ROOF PLANS

 Project Number
 202110


 Date
 07.22.2022

 Drawn By
 MS

 Checked By
 NP

A102

Scale As indicated

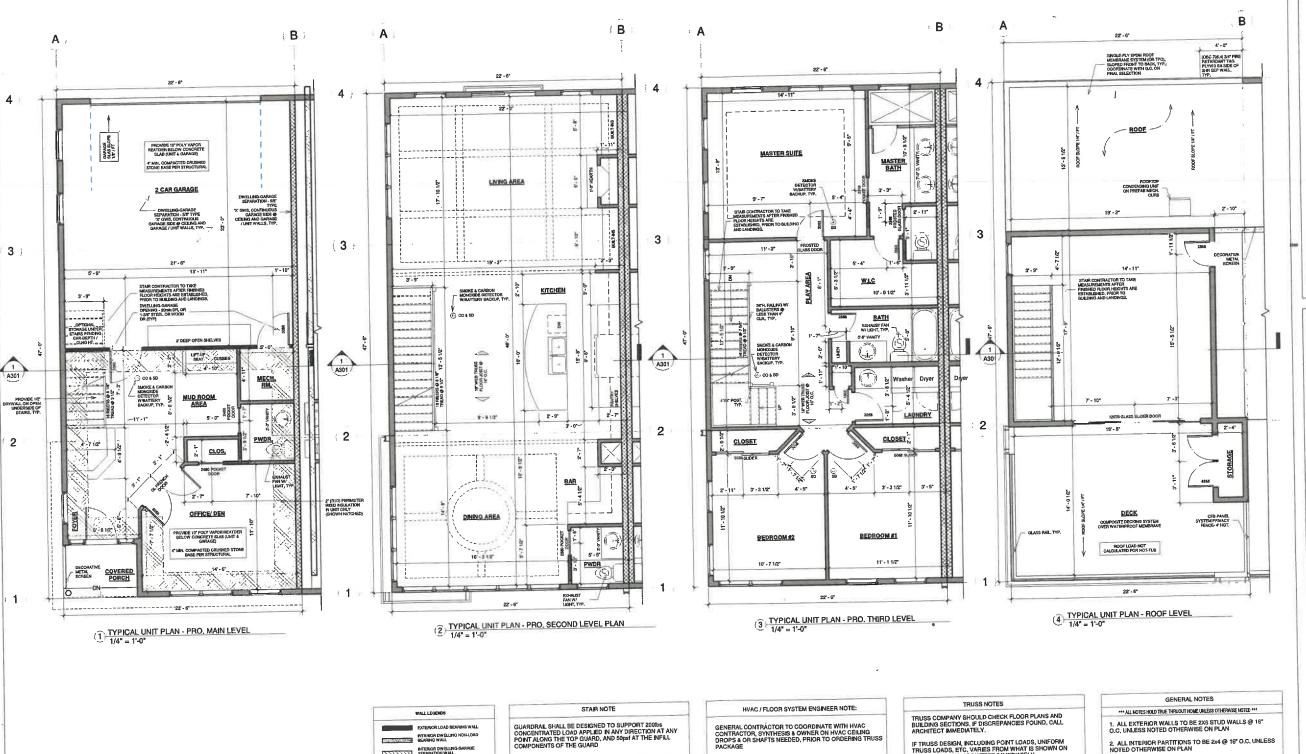

INDIVIDUAL STAIR TREADS SHALL BE DESIGNED FOR THE UNIFORMLY DISTRIBUTEDY LIVE LOAD OF 40pet OR A 300lbs CONCENTRATED LOAD ACTING OVER AN AREA OF 4 SQUARE INCHES, WHICHEVER PRODUCES THE GREATER STRESSES.

TRUSS NOTES

GLASS RAIL NOTE

ALL GLASS TEMP. SPECIFICATIONS WILL BE PROVIDED BY G.C. AFTER FINAL MANUFACTURER SELECTION.

G.C. TO COORDINATE WITH SYNTHESIS AND TRUSS ENGINEER ON FINAL CELLING HEIGHT AND TRAY CONFIGURATION PRIOR TO ORDERING TRUSSES.

EXTERIOR LOAD SEARING WALL

INTERIOR DWELLING NON-BEARING WALL

INTERIOR 24R FIRE RATED WAL

INTERIOR 1-HR FIRE RATED WALL

INTERIOR PARTIAL HEIGHT WALL

TRUSS COMPANY SHOULD CHECK FLOOR PLANS AND BUILDING SECTIONS. IF DISGREPANCIES FOUND, CALL ARCHITECT IMMEDIATELY.

IF TRUSS DESIGN, INCLUDING POINT LOADS, UNIFORM TRUSS LOADS, ETC. VARIES FROM WHAT IS SHOWN ON THE PLANS, CALL ARCHITECT IMMEDIATELY.

IF HEEL CUTS NEED TO BE ADJUSTED BY TRUSS MANUFACTURER FROM WHAT SHOWN ON ELEVATIONS CALL ARCHITECT IMMEDIATELY.

PROVIDE CONTINUOUS BEARING TO FOUNDATION BELOW ALL MULTI- PLY TRUSSES.

GENERAL CONTRÁCTOR TO COORDINATE WITH HVAC CONTRACTOR, SYNTHESIS & OWNER ON HVAC CEILING DROPS & OR SHAFTS NEEDED, PRIOR TO ORDERING TRUSS PACKAGE

SMOKE DETECTOR NOTE

SMOKE ALARMS SHALL BE NSTALLED ON EACH LEVEL OF THE HOUSE, AND SHALL UTLIZE PHOTOELECTRIC AND INIZATION TECHNOLOGIES, SMOKE ALARMS IN THE VICINITY OF BEDROOMS SHALL UTLIZE PHOTOELECTRIC TECHNOLOGY, SMOKE ALARMS IN BEDROOMS SHALL BE DUAL-SENSING OR UTLIZE (IONIZATION TECHNOLOGY.

FRAMING NOTE FIRST FLOOR TRUSS AND SUBFLOOR MUST BE INSTALLED AND SECURELY FASTENED TO FOUNDATION ANCHORAGE BEFORE BACKFILLING, TRAY AND COFFERED CLNGS ARE CONSTRUCTED WITHIN THE TRUSS CONFIGURATION UNLESS NOTED OTHERWISE

TRAY AND COFFERED CLINGS SHOULD CONSTRUCTED TO MAXIMUM INTERIOR HEIGHT THAT IS POSSIBLE. (COORDINATE W/ ARCHITECT)

TRUSSES TO BE CONFIGURED TO MAINTAIN OVERHANG WIDTH THE SAME FOR BRICK AND STONE VENEER AREAS.

ENGINEERED ROOF TRUSS DRAWINGS WITH A LAYOUT SHEET SHALL BE FURNISHED TO THE BUILDING INSPECTOR FOR THE FRAMING INSPECTION

ALL EXTERIOR WALLS TO BE 2X6 STUD WALLS @ 16"
 O.C. UNLESS NOTED OTHERWISE ON PLAN

2. ALL INTERIOR PARTITIONS TO BE 2x4 @ 16" O.C. UNLESS NOTED OTHERWISE ON PLAN

3. ALL EXTERIOR DOOR AND WINDOW HEADERS TO BE (2) 2x12's, w/ 2 JACK STUDS TO SUPPORT HEADER.

4.  $\odot_{\mathrm{SD}}$  = 110V. INTER-CONNECTED SMOKE DETECTOR w/ BATTERY BACK-UP. 5. (6) = SOLID BLOCKING TO T/FDN OR T/BEAM BELOW (3 JACK STUD MIN.)

6. 1 3/4" WOOD OR STEEL INSULATED EXTERIOR DOORS. 7. 1 3/4" WOOD 6-PANEL INTERIOR DOORS.

8. ALL STAIR RAILINGS TO BE NO LESS THAN 36" ABV. NOSING AND BALUSTERS SPACED LESS THAN 4" CLEAR.

9. THE ENDS OF ALL 1/2 WALLS NOT VERTICALLY SUPPORTED SHALL PENETRATE SUBFLOOR W/ (2) 2X4'S AND THE SECURELY MITO THE FLOOR JOISTS BELOW W/ SOLID BLOCKING ON ALL 4 SIDES.

10. WINDOW HEADERS TO BE AT 9'- 9 3/8" ABOVE EACH FLOOR UNLESS OTHERWISE NOTED.

# **UNIT PLANS**

Rev. No. Description

**TOWNHOM** 

OD

DRAKEWO

CTION OF WASSON RD. CINCINNATI, OH

513.223.5023 | studio@synthesisarchitectu synthesisarchitecture.

Date

**PROPERTIES** 

TYLER INVESTMENT

202110 07.22.2022 Drawn By NP Checked By

Scale

1/4" = 1'-0"